
SITE PLAN - EXISTING

1" = 50'-0"

NOTICE
HOURS OF WORK: 7AM TO 8PM MON-FRI
9AM TO 6PM SAT. NO WORK SUNDAYS &
HOLIDAYS (PER KZC SEC. 115.25)
Exceptions must be approved in
writing by Planning Official

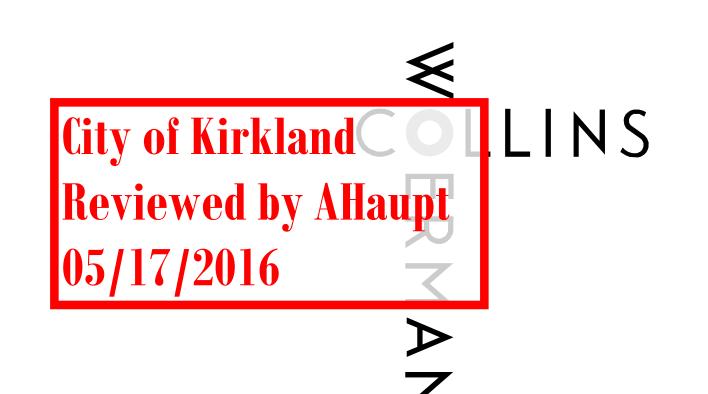

710 SECOND AVENUE ■ SUITE 1400 SEATTLE, WASHINGTON 98104-1710 T ■ 206 245 2100 F ■ 206 245 2101 URL ■ WWW.COLLINSWOERMAN.COM

KIRKLAND URBAN

321 PARKPLACE CENTER KIRKLAND, WA 98033

PACKAGE #1A SITE DEMOLITION

CONSULTANT

ISSUED:

MARK DATE DESCRIPTION

PROJECT NUMBER PRUD01.14.016


DRAWN BY
ISSUE DATE
SEAL


SHEET TITLE / NUMBER

**BUILDING D** 

MODIFICATION PLAN

© 2014 COLLINSWOERMAN, ALL RIGHTS RESERVED

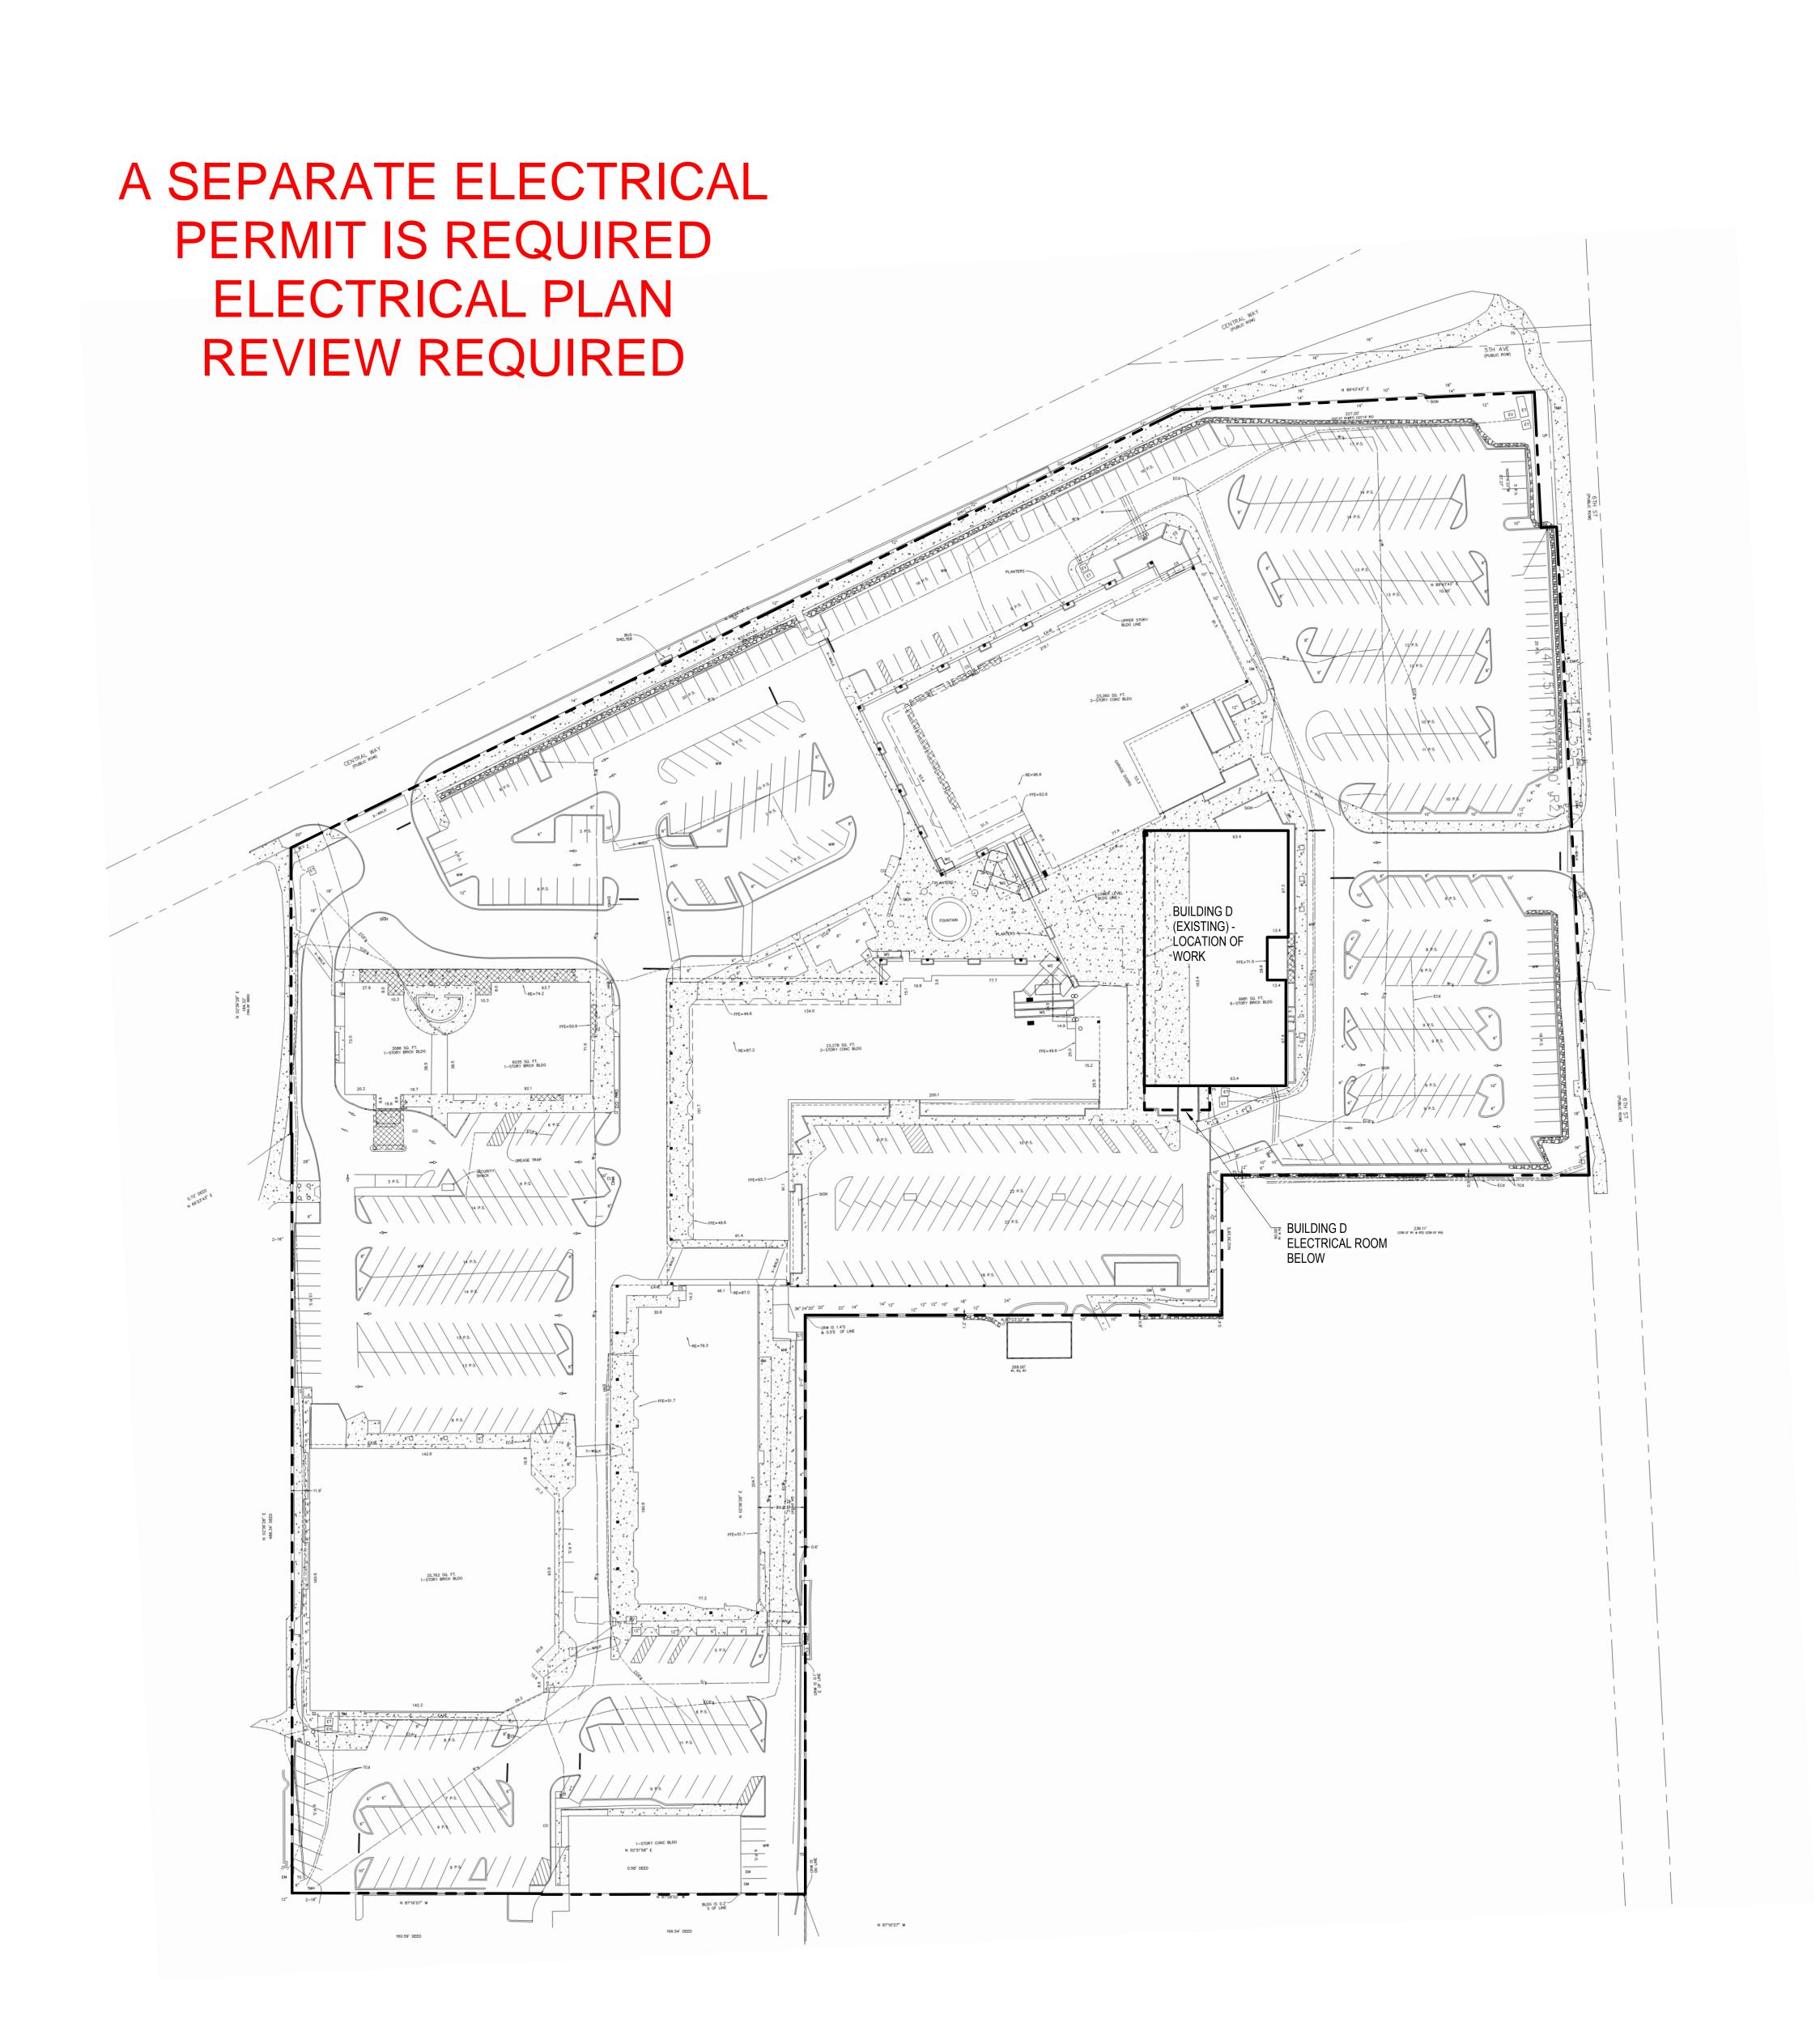

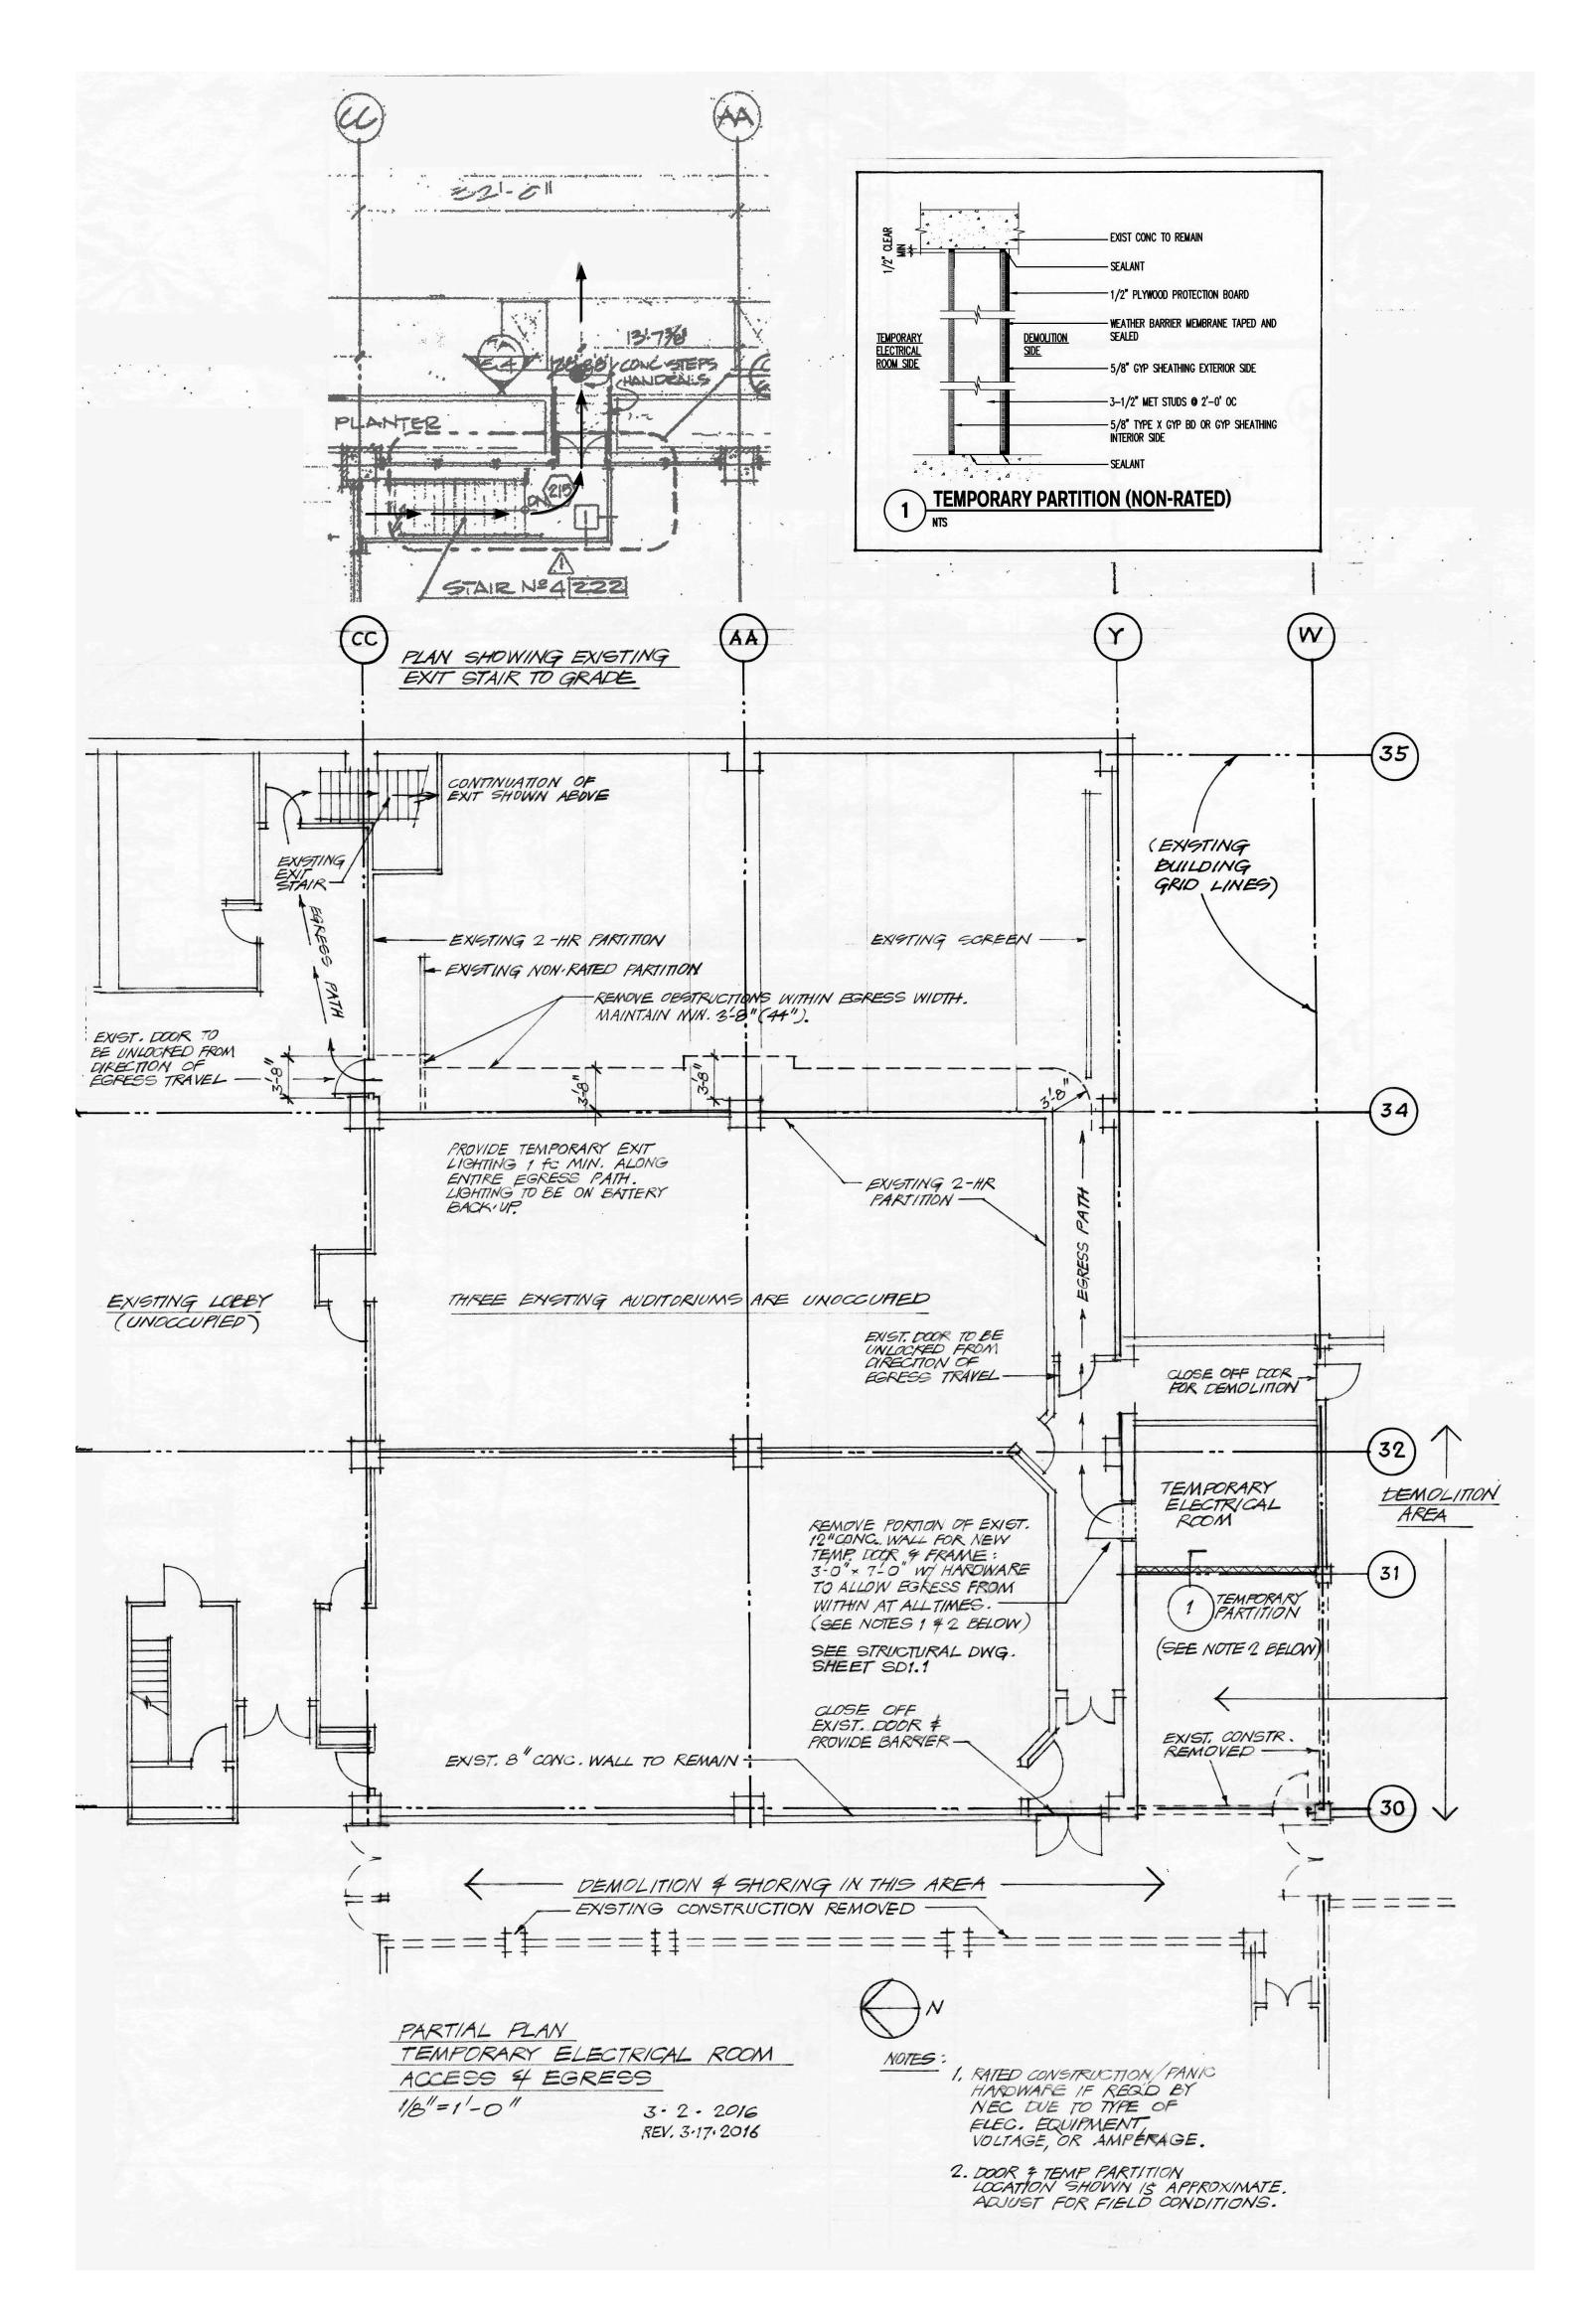

1 BUILDING D MODIFICATION PLAN - LEVEL 1

## General Structural Notes

(THE FOLLOWING APPLY UNLESS SHOWN OTHERWISE ON THE DRAWINGS.)

- 1. ALL MATERIALS, WORKMANSHIP, DESIGN, AND CONSTRUCTION SHALL CONFORM TO THE DRAWINGS, SPECIFICATIONS, AND THE INTERNATIONAL BUILDING CODE (IBC) <WITH WASHINGTON STATE ADMINISTRATIVE CODE AMENDMENTS>, 2012 EDITION.
- 2. CONTRACTOR SHALL VERIFY ALL EXISTING DIMENSIONS, MEMBER SIZES AND CONDITIONS PRIOR TO COMMENCING ANY WORK AND GUIDELINES ONLY AND MUST BE VERIFIED. THE EXISTING CONDITIONS SHOWN ON THE DRAWINGS ARE BASED EITHER ON SITE CLOSELY MATCH THE CONDITIONS SHOWN ON THE DRAWINGS, OR IF THE EXISTING MATERIALS ARE OF QUESTIONABLE OR SUBSTANDARD QUALITY, NOTIFY THE ENGINEER PRIOR TO COMMENCING ANY WORK.
- 3. <u>CONTRACTOR</u> SHALL PROVIDE TEMPORARY BRACING, BOTH FOR VERTICAL LOADS AND LATERAL STABILITY, FOR THE STRUCTURE AND STRUCTURAL COMPONENTS UNTIL ALL FINAL CONNECTIONS HAVE BEEN COMPLETED IN ACCORDANCE WITH THE DRAWINGS.
- 4. CONTRACTOR SHALL BE RESPONSIBLE FOR ALL SAFETY PRECAUTIONS AND THE METHODS, TECHNIQUES, SEQUENCES OR PROCEDURES REQUIRED TO PERFORM THE WORK.
- 5. <u>DEMOLITION</u>: CONTRACTOR SHALL VERIFY ALL EXISTING CONDITIONS BEFORE COMMENCING ANY DEMOLITION. SHORING SHALL BE INSTALLED TO SUPPORT EXISTING CONSTRUCTION AS REQUIRED AND IN A MANNER SUITABLE TO THE WORK SEQUENCES. DEMOLITION DEBRIS SHALL NOT BE ALLOWED TO DAMAGE OR OVERLOAD THE EXISTING STRUCTURE. LIMIT CONSTRUCTION LOADING (INCLUDING DEMOLITION DEBRIS) ON EXISTING STRUCTURE TO 50 PSF.
- A. ALL NEW OPENINGS THROUGH EXISTING CONCRETE WALLS SHALL BE ACCOMPLISHED BY SAWCUTTING WHEREVER POSSIBLE. UNLESS OTHERWISE NOTED, ALL NEW OPENINGS SHALL BE SAWCUT NEAT AND CLEAN; NO OVERCUTTING AT OPENING CORNERS SHALL BE ALLOWED. AS REQUIRED, CORE DRILL CORNERS AND CHIP, GRIND OR CUT THE CORNERS TO PROVIDE THE REQUIRED DIMENSIONS.
- B. CONTRACTOR SHALL VERIFY ALL EXISTING CONDITIONS AND LOCATION OF MEMBERS PRIOR TO CUTTING ANY OPENINGS.
- 6. STATEMENT OF SPECIAL INSPECTIONS STRUCTURAL ITEMS:

SPECIAL INSPECTIONS AND TESTING SHALL BE PERFORMED BY THE OWNER APPOINTED INSPECTION AGENCY IN ACCORDANCE WITH CHAPTER 17 OF THE IBC WITH REPORTS PER IBC SECTION 1704.2.4 SUBMITTED TO THE OWNER, ARCHITECT, STRUCTURAL ENGINEER, CONTRACTOR, AND BUILDING OFFICIAL FOR EACH DAY SPECIAL INSPECTIONS OR TESTING IS PERFORMED. THESE INSPECTIONS ARE IN ADDITION TO THE INSPECTIONS SPECIFIED IN IBC SECTION 110. SEE TABLES BELOW FOR ADDITIONAL

SPECIAL INSPECTION FREQUENCY

IBC REFERENCE

STRUCTURAL STEEL FABRICATION, ERECTION, AND NONDESTRUCTIVE TESTING\*

CONTINUOUS/PERIODIC (QA PER AISC 360 CH. N5.4) 1705.2.1

EXPANSION BOLTS & INSERTS PERIODIC INCLUDING TORQUE TESTS IN ACCORDANCE TABLE 1705.3 ITEM 4

1705.11

EPOXY GROUTED RODS OR REBAR PERIODIC INCLUDING INSPECTION OF EMBEDMENT TABLE 1705.3 ITEM 4, DEPTH AND HOLE CLEANLINESS PRIOR TO ALL ACI 318-11 SECTION D9.2 INSTALLATIONS (CONTINUOUS FOR UPWARDLY INCLINED ANCHORS)

EPOXY BONDED STEEL PLATES CONTINUOUS

- 7. <u>EXPANSION BOLTS INTO CONCRETE</u> SHALL BE "KWIK BOLT TZ" AS MANUFACTURED BY HILTI, INC. AND INSTALLED IN STRICT ACCORDANCE WITH ICC-ES REPORT NO. 1917 AND MANUFACTURER'S INSTRUCTIONS. SUBSTITUTES PROPOSED BY CONTRACTOR SHALL BE SUBMITTED FOR REVIEW WITH ICC-ES REPORTS INDICATING EQUIVALENT OR GREATER LOAD CAPACITIES. IN ADDITION, SUBSTITUTIONS SHALL MEET ICC-ES ACCEPTANCE CRITERIA AC193. SPECIAL INSPECTION IS REQUIRED FOR ALL EXPANSION BOLT INSTALLATION. EXPANSION BOLTS SHALL NOT BE USED AS SUBSTITUTES FOR EMBEDDED ANCHOR BOLTS UNLESS SPECIFICALLY APPROVED BY THE STRUCTURAL ENGINEER. NOTIFY ENGINEER IF BOLT LOCATIONS CONFLICT WITH REINFORCING STEEL - DO NOT CUT REINFORCING OR REDUCE EMBEDMENT DEPTHS WITHOUT PRIOR APPROVAL.
- 8. EPOXY-GROUTED RODS OR REBAR TO CONCRETE SPECIFIED ON THE DRAWINGS SHALL BE GROUTED WITH "HIT-HY 200" AS MANUFACTURED BY HILTI, INC. AND INSTALLED IN STRICT ACCORDANCE WITH ICC-ES REPORT NO. 3187 ("SAFE-SET" INSTALLATION WITH HOLLOW CARBIDE DRILL BIT IS PERMITTED), INCLUDING MINIMUM EMBEDMENT REQUIREMENTS. SUBSTITUTES PROPOSED BY CONTRACTOR SHALL BE SUBMITTED FOR REVIEW WITH ICC-ES REPORTS INDICATING EQUIVALENT OR GREATER LOAD CAPACITIES. IN ADDITION, SUBSTITUTIONS SHALL MEET ICC-ES ACCEPTANCE CRITERIA AC308. SPECIAL INSPECTION OF EPOXY-GROUTED ANCHOR INSTALLATION IS REQUIRED. EPOXY GROUTED RODS OR REBAR SHALL NOT BE USED AS SUBSTITUTES FOR CAST-IN-PLACE ANCHOR BOLTS OR REINFORCING STEEL UNLESS SPECIFICALLY APPROVED BY THE STRUCTURAL ENGINEER. NOTIF ENGINEER IF ANCHOR LOCATIONS CONFLICT WITH REINFORCING STEEL - DO NOT CUT REINFORCING OR REDUCE EMBEDMENT DEPTHS WITHOUT PRIOR APPROVAL.
- 9. EPOXY BONDED STEEL PLATES SHALL BE BONDED WITH KEMKO 038 EPOXY OR APPROVED EQUIVALENT CONFORMING TO ASTM C 881 EPOXY SHALL BE INSTALLED BY A SPECIALTY CONTRACTOR WITH EXPERIENCE IN STRUCTURAL EPOXY BONDED STEEL PLATE INSTALLATION. SURFACE PREPARATION AND EPOXY INSTALLATION SHALL BE PERFORMED IN STRICT ACCORDANCE TO THE MANUFACTURER'S INSTRUCTIONS.

### Sequence of Operation for the Demo around the Existing Electric Room

1. Low Voltage Communication Conduits/Services will be rerouted and re fed from from the southwest side of the building. Electrical Services feeding building D will not need to be relocated. 2. Add additional steel plating each side of the existing concrete joist within the Electric room and Stairwell between Gridlines EX. 31 and EX. 33

3. Install a Steel T bracket at each Joist, secured to the existing wall to bridge the expansion joint on the west side of the enclosure.

- 4. To secure the room, we will be adding a partition at Gridline EX. 31.
- 5. Once all supports are in place, the concrete structure outside of the space will be sawcut to
- remove any weight of the garage from the added supports.

  6. For access to the electric room, there will be a 3' 0"W x 7' 0"T Doorwall cut and installed in the existing concrete structure on the west wall.

# ALL Welding:

Is required to be done by a WABO certified welder and have Special Inspections by a WABO certified Inspection Agency

Be done in a WABO certified fabrication shop.

Have either the special inspection report or the WABO fabrication shop certification available on site for the Building Inspector.

